



# Bid B2015-35

City of Torrance | 3031 Torrance Blvd, Torrance CA 90503 | www.TorranceCA.Gov

# Addendum #1

**Bid No. B2015-35**

**Proposal, Bond and Affidavit for the Construction of Transit Park and Ride Regional Terminal Phase 1 - Rough Grading - FEAP 764**

**ADDENDUM NO. 1  
Issued: October 27, 2015**

**TO**

**PROPOSAL, SPECIFICATIONS, BOND AND  
AFFIDAVIT FOR THE CONSTRUCTION  
OF  
TORRANCE TRANSIT PARK AND RIDE REGIONAL TERMINAL  
PHASE 1 – ROUGH GRADING - FEAP 764  
B2015-35**

Note the following changes and/or additions to the Specifications for the project indicated above. The Bidder shall execute the Certification at the end of this addendum, and shall **attach all pages of this addendum to the Contract Documents submitted with the Bid**. In addition, the bidder shall complete and submit the "Acknowledgment of Addenda Received" Form provided in Section C of the Specifications.

1. **Refer to Section G - Project Manual CSI Specification, Appendix A - Geotechnical Report, Section 4.2.1 Site Preparation and Grading, Table 4 - Import Fill and Select Backfill Criteria, Appendix A Page 12**

Replace Table 4 - Import Fill and Select Backfill Criteria with Revised Table 4 in the "Import Fill Recommendations" letter by Diaz Yourman & Associates attached.

2. **Refer to Advanced / Rough Grading Plan Drawing No. C-4 and C-6**

Replace Drawing No. C-4 and C-6 with revised drawings C-4 and C-6 attached.

Addendum Issued By Order Of,

Ted Semaan, P.E.  
Engineering Manager - Major Projects  
October 27, 2015

.....  
**BIDDER'S CERTIFICATION**

I acknowledge receipt of the foregoing Addendum No. 1 and accept all conditions contained therein.

\_\_\_\_\_  
Bidder

\_\_\_\_\_  
By

\_\_\_\_\_  
Date



October 26, 2015

Project No. 2013-031

Mr. Keith Fine  
Frank R. Webb Architects  
8607 Venice Blvd.  
Los Angeles, CA 90034

Subject: Import Fill Recommendations  
Torrance Transit Park and Ride Regional Terminal  
465 Crenshaw Boulevard  
Torrance, California

Dear Mr. Fine:

This letter presents Diaz•Yourman & Associates' (DYA) additional recommendations. Previously, DYA summarized the results of our geotechnical investigation in our report for the subject project dated April 14, 2014 (Report). Based on our discussions, we understand that it would be beneficial to the project to revise the recommended properties for import fill included in Table 4 of the Report. Revised recommendations are included in the table below:

**Revised Table 4 - IMPORT FILL AND SELECT BACKFILL CRITERIA**

CRITERIA	IMPORT FILL	SELECT BACKFILL
Maximum particle size (inches)	3	1
Maximum liquid limit (%)	30	5
Maximum plasticity index (%)	10	0
Maximum percentage passing the No. 200 sieve (%)	40	30
Minimum sand equivalent	N/A	20



We appreciate the opportunity to work with you on this project. Please call if you have any questions.

Sincerely,

DIAZ•YOURMAN & ASSOCIATES

Matt Dennerline, PE, GE




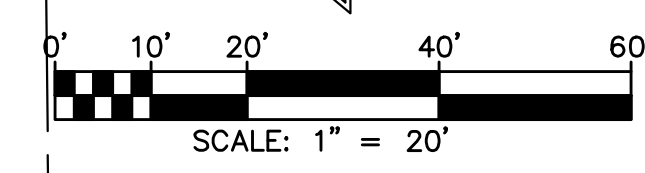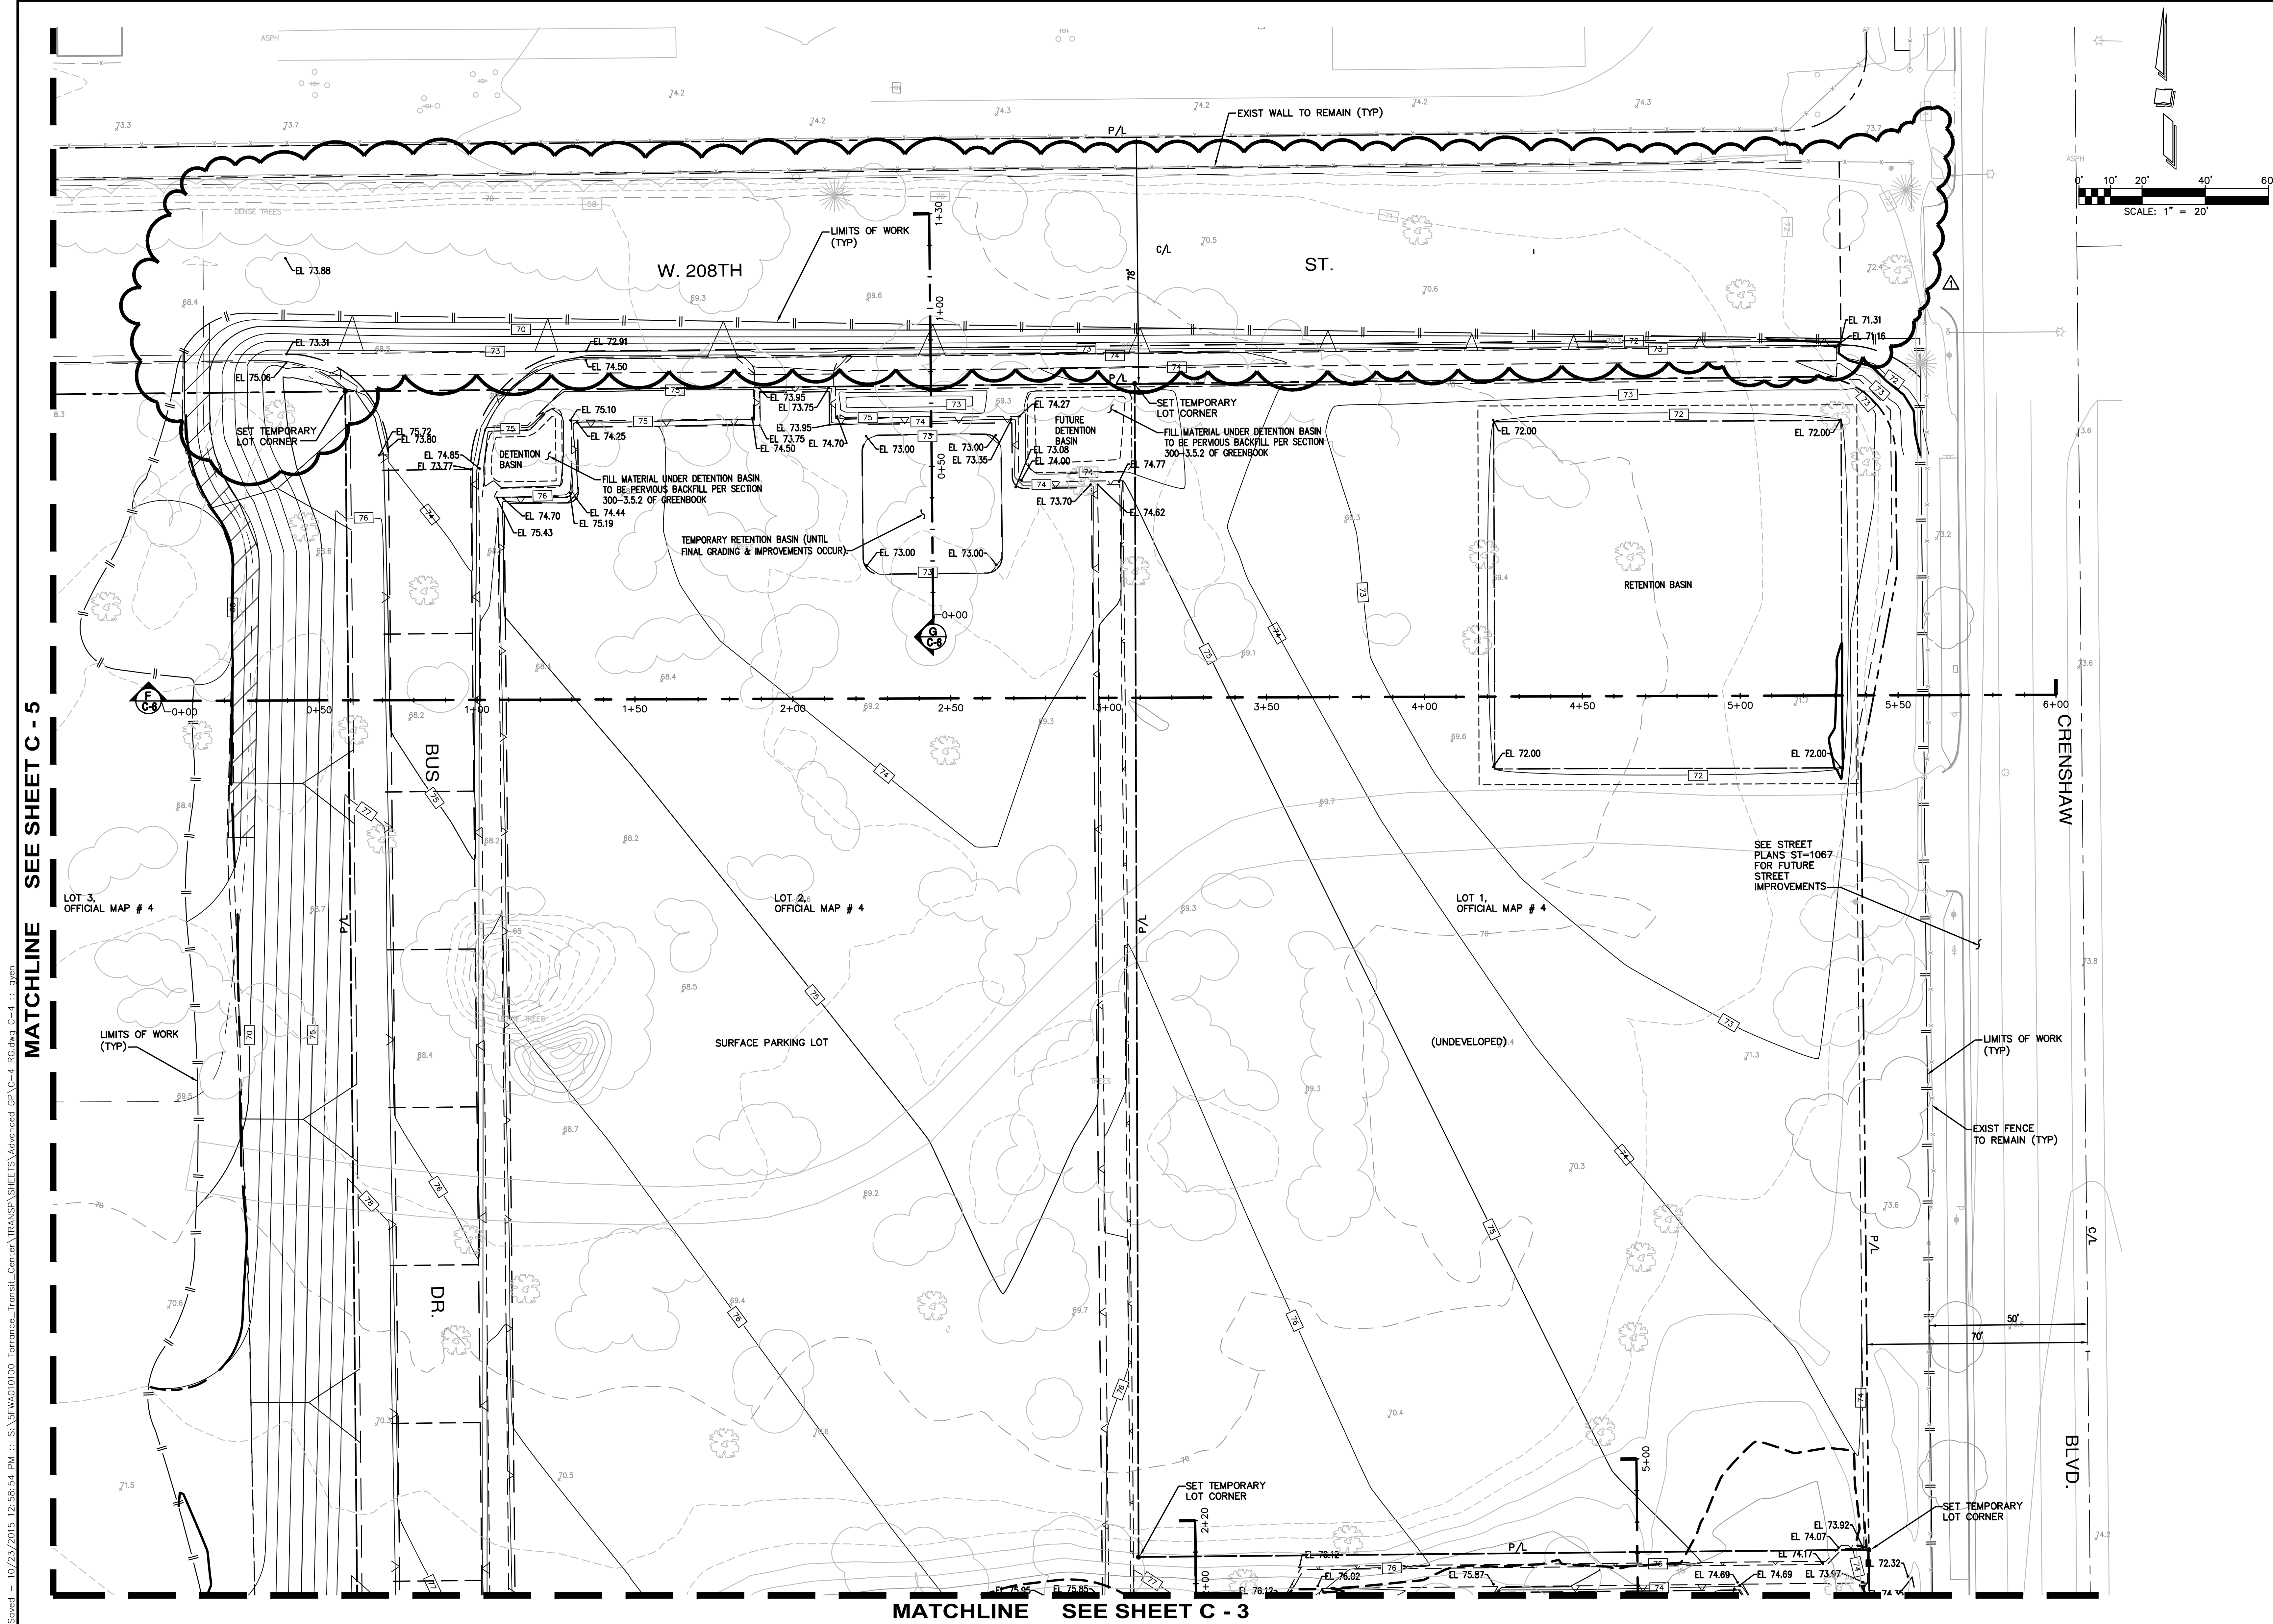

No.	Distribution/Revision	Date
1	REVISE SLOPE AT W. 208TH ST.	10-23-15

**PSOMAS**

3111 Camino Del Rio North, Suite 702  
 San Diego, CA 92108  
 (619) 961-2800 (619) 961-2392 fax  
 www.psomas.com

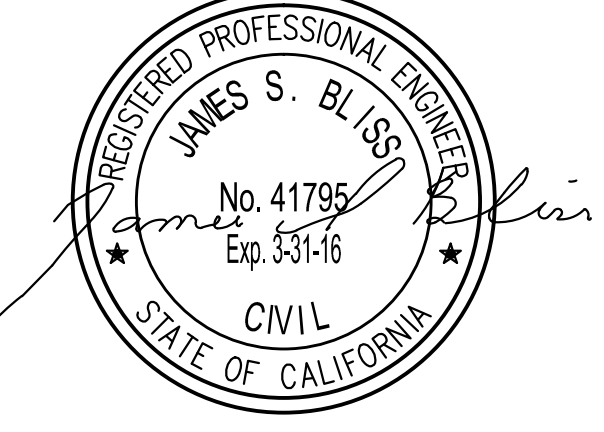

MATCHLINE SEE SHEET C - 5

MATCHLINE SEE SHEET C - 3



City of Torrance  
 Torrance Transit Park & Ride  
 Regional Terminal  
 465 Crenshaw Blvd.  
 Torrance, CA 90503

**Torrance Transit  
 Park and Ride  
 Regional  
 Terminal**

CLIENT PROJECT #B2013-15  
 Drawing Title

**ADVANCED / ROUGH  
 GRADING PLAN**

Scale: 1" = 20'  
 IF DRAWING IS NOT 30x42 THEN IT IS NOT TO SCALE


Project Manager	LA
Project No.	JSB
Date Plotted	13025

SEE CONSTRUCTION AND SUPPLEMENTAL  
 GRADING NOTES ON SHEET C-3


**C-4**

Plotted - 10/23/2015 11:58:02 PM :: Saved - 10/23/2015 12:58:54 PM :: S:\5FW\010100 Torrance - Torrance\Transit Park and Ride\Regional Terminal\TRANSIT SHEETS\Advanced GR C-4.RC.dwg C-4.rvt gwh




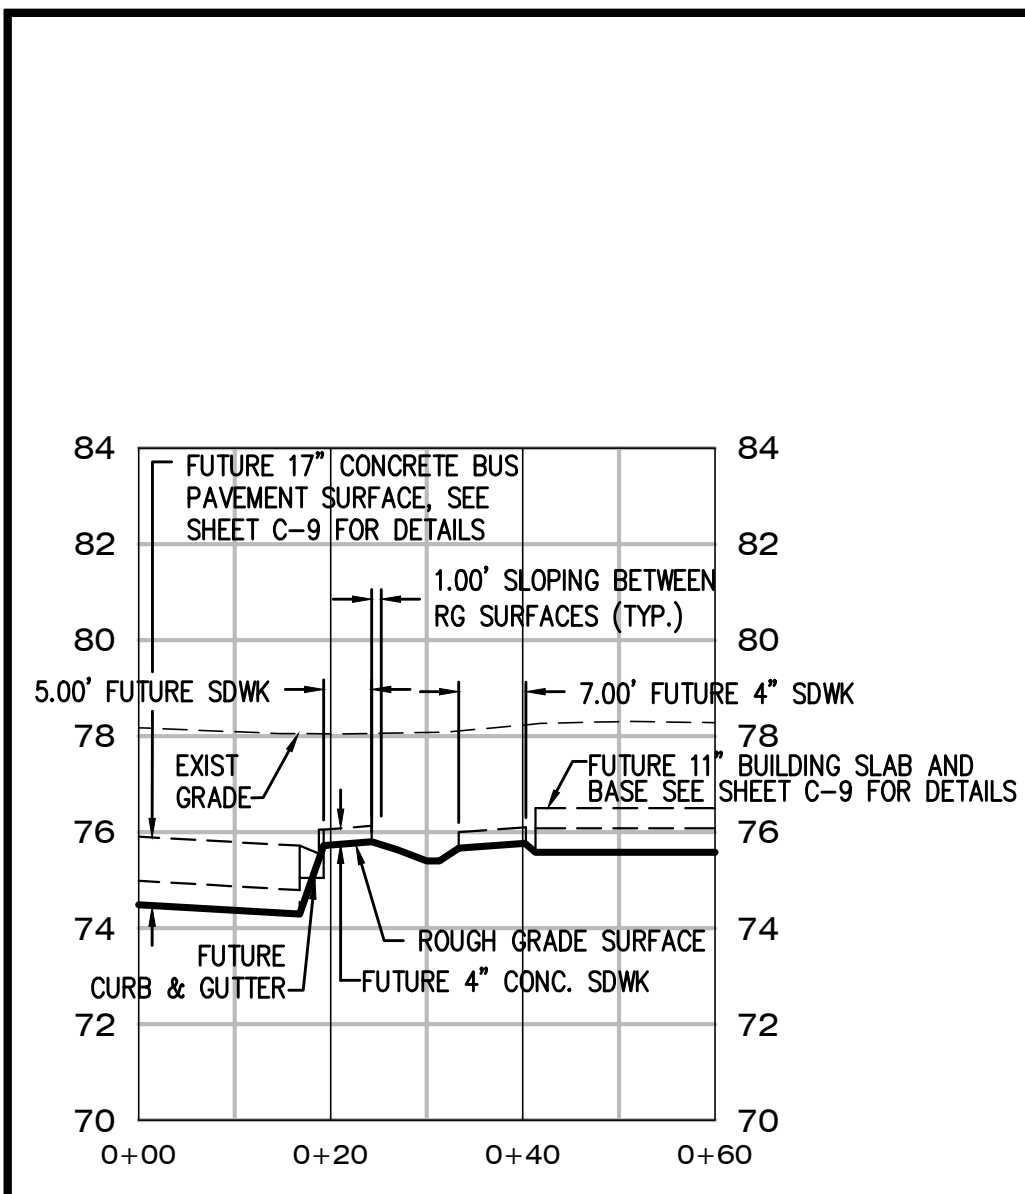


**SITE SECTION A**  
SCALE: 1"=20' H, 1"=4' V

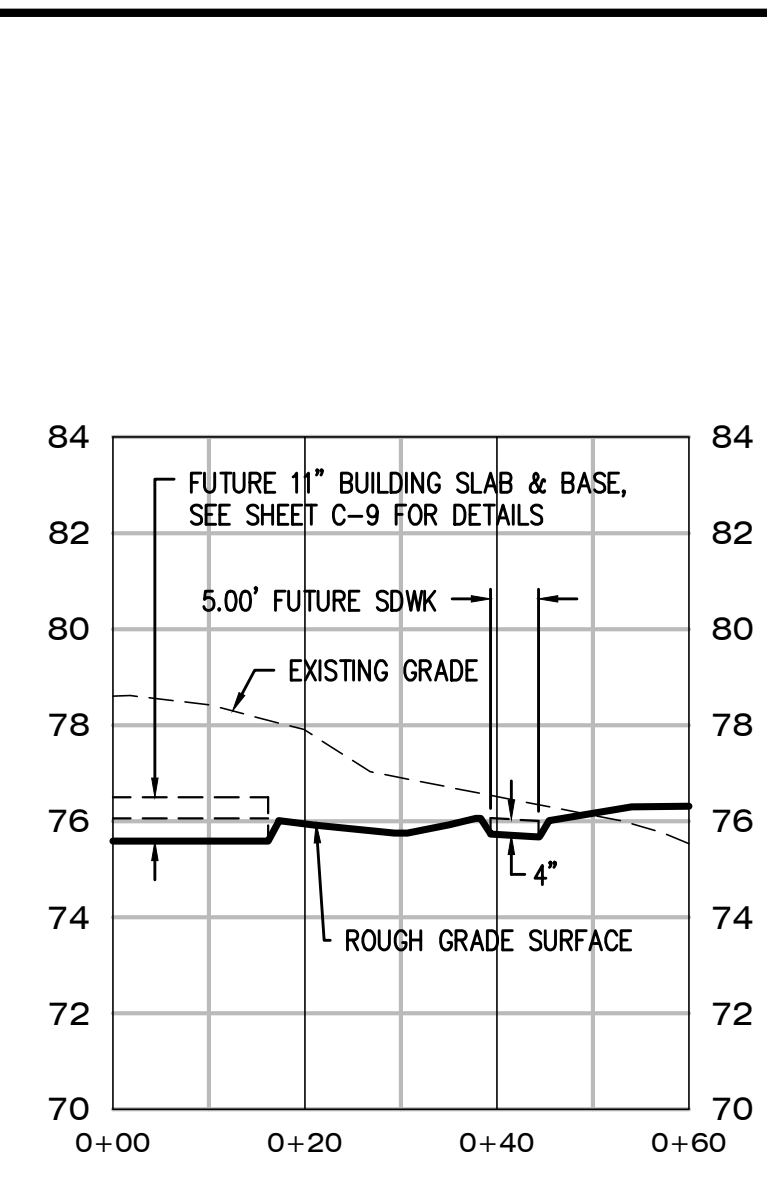


**SITE SECTION B**  
SCALE: 1"=20' H, 1"=4' V

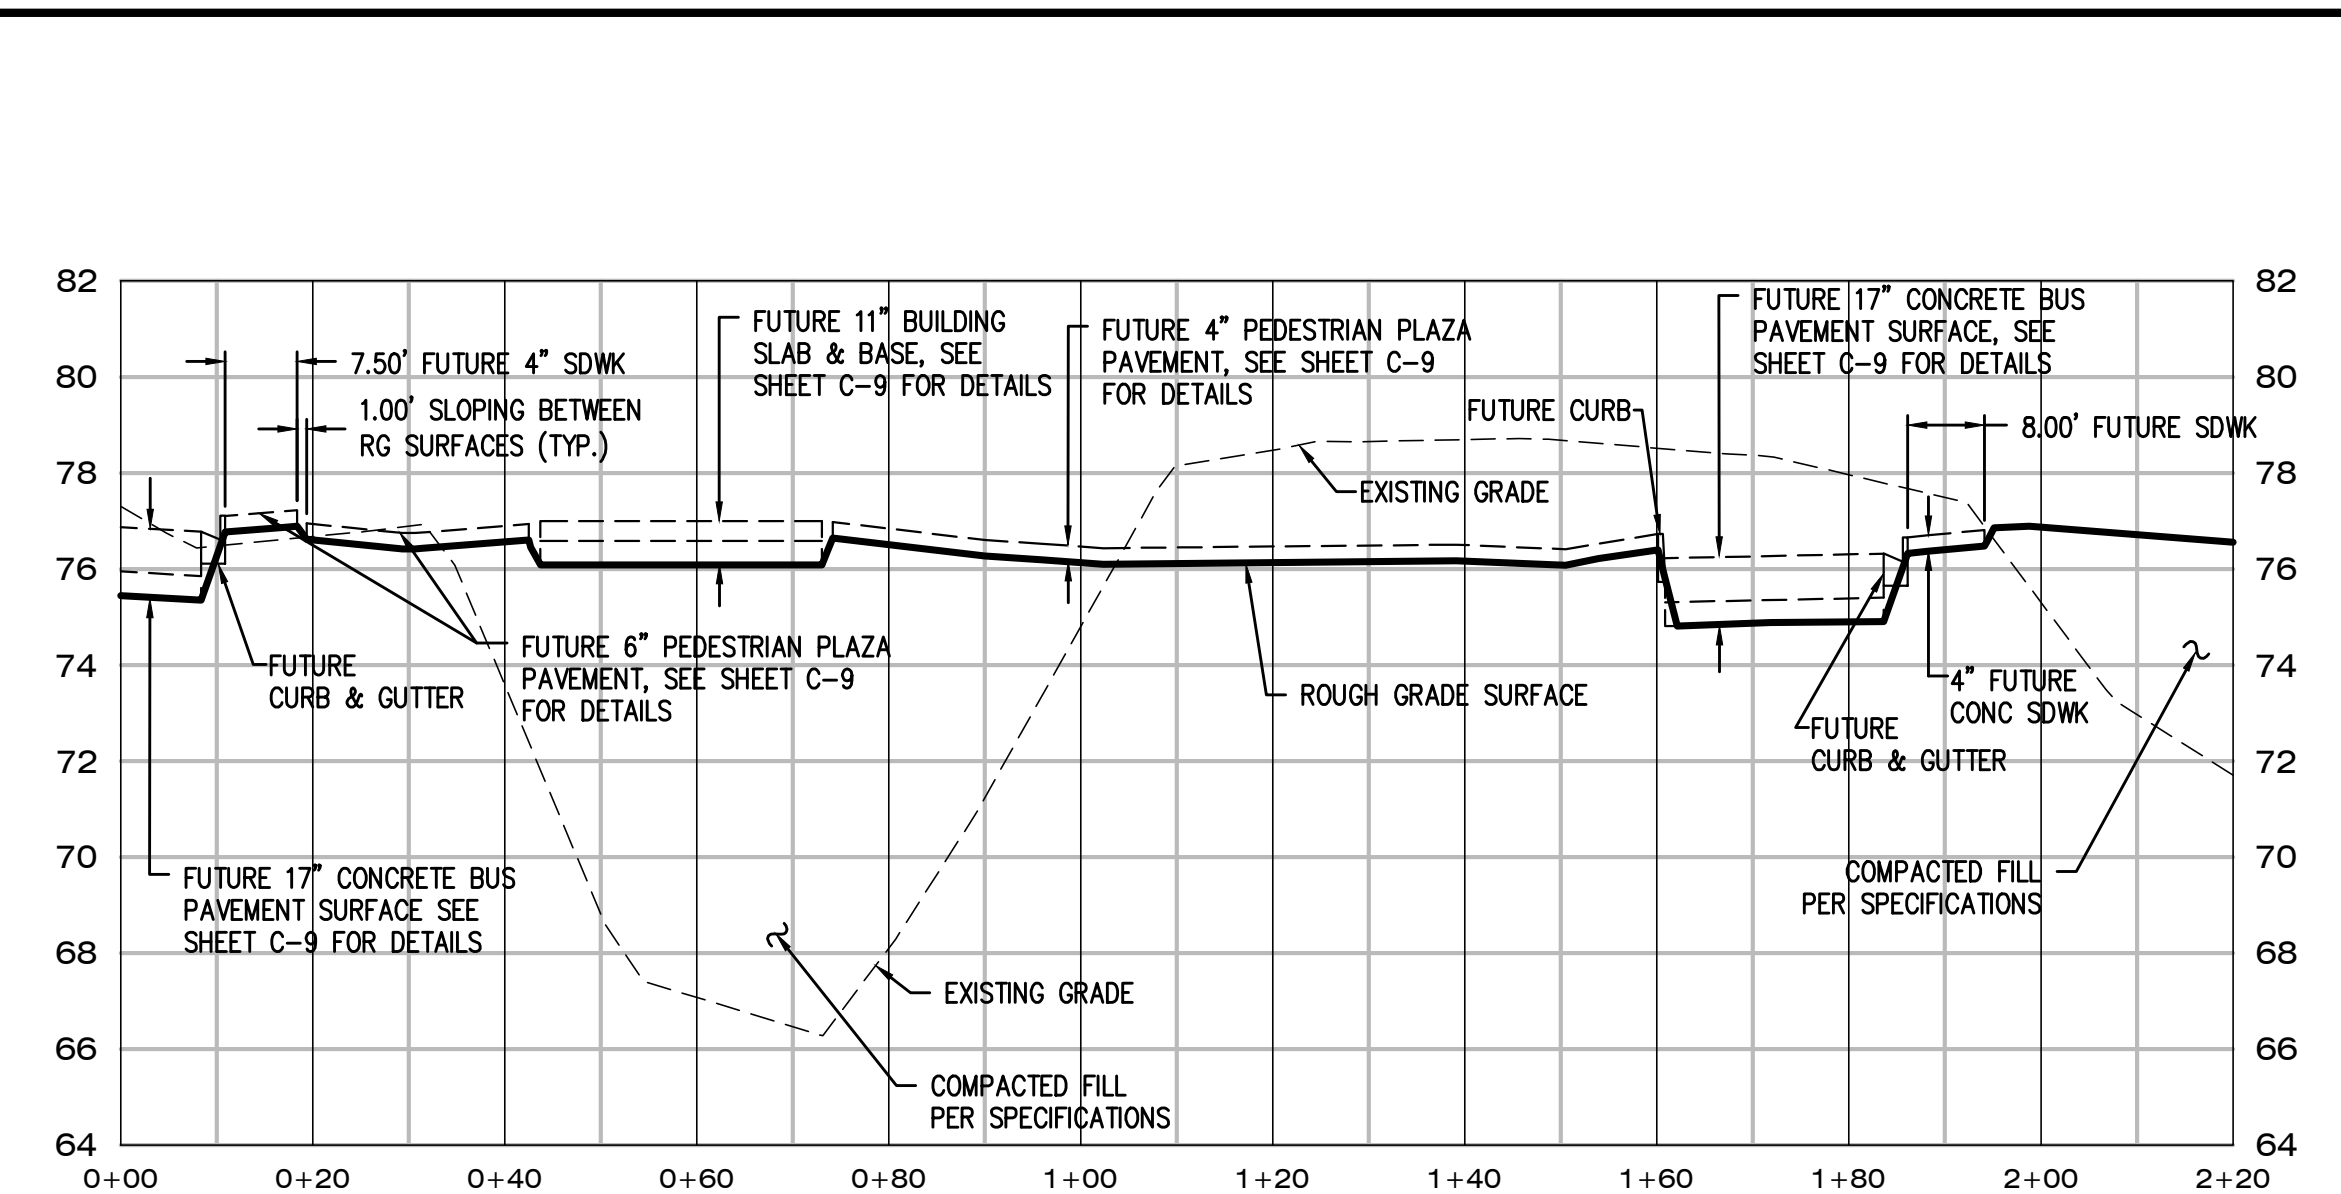


**SITE SECTION D**  
SCALE: 1"=20' H, 1"=4' V

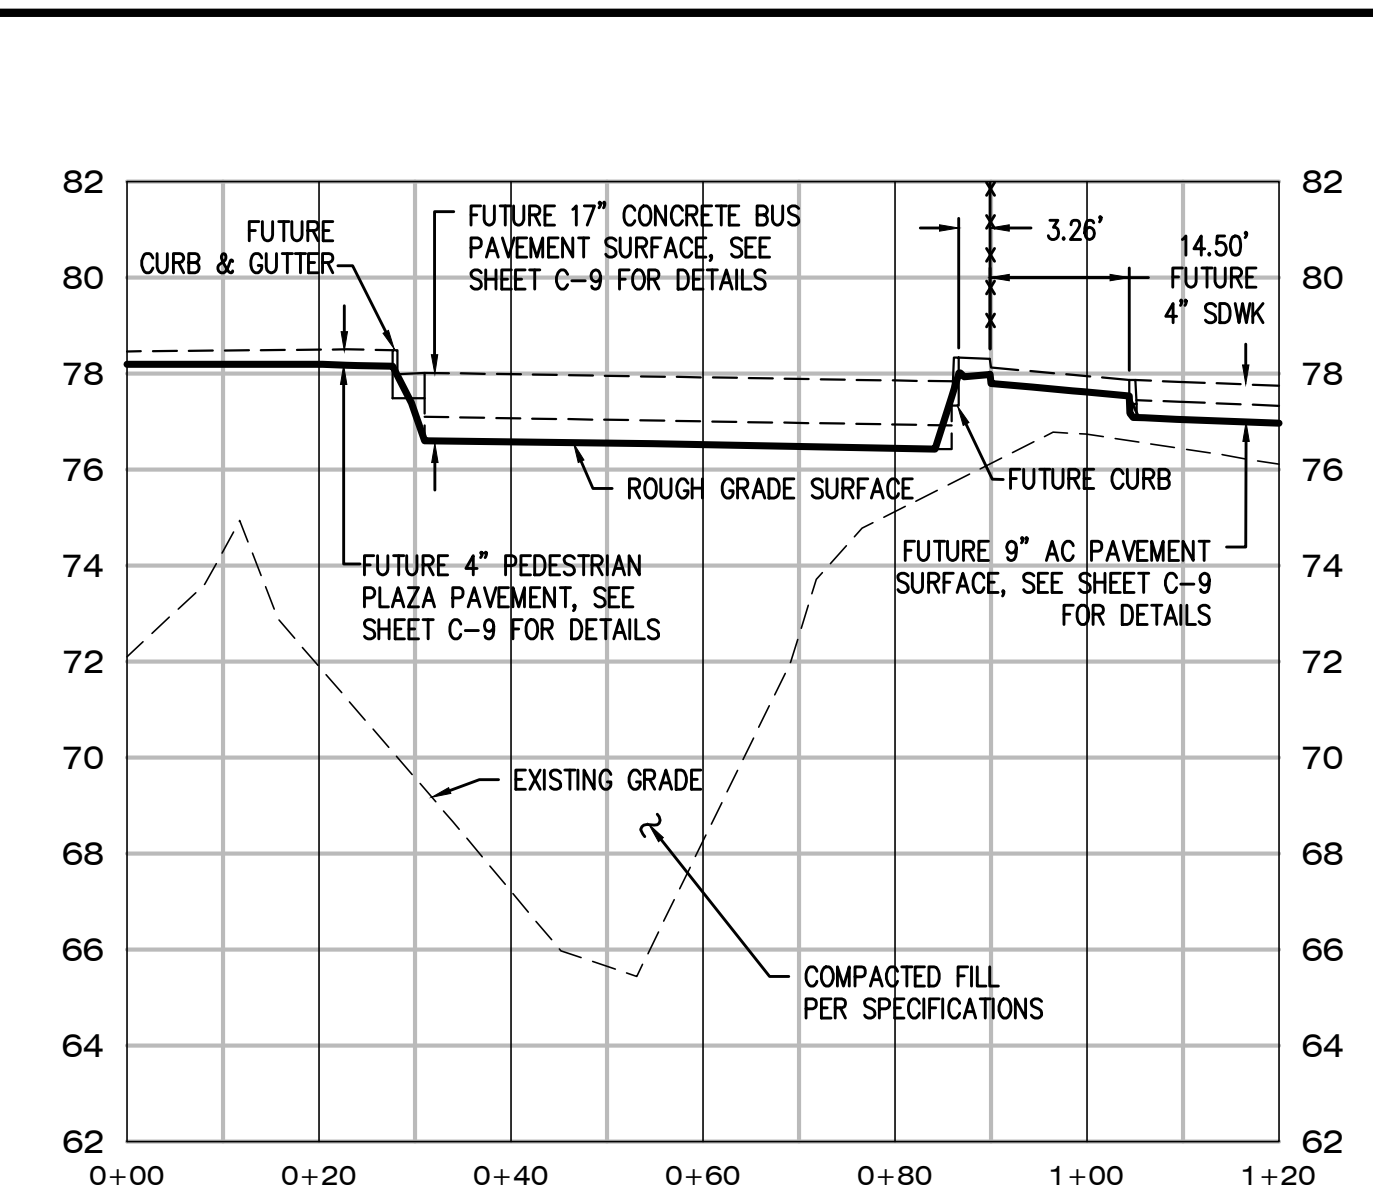


**SITE SECTION E**  
SCALE: 1"=20' H, 1"=4' V

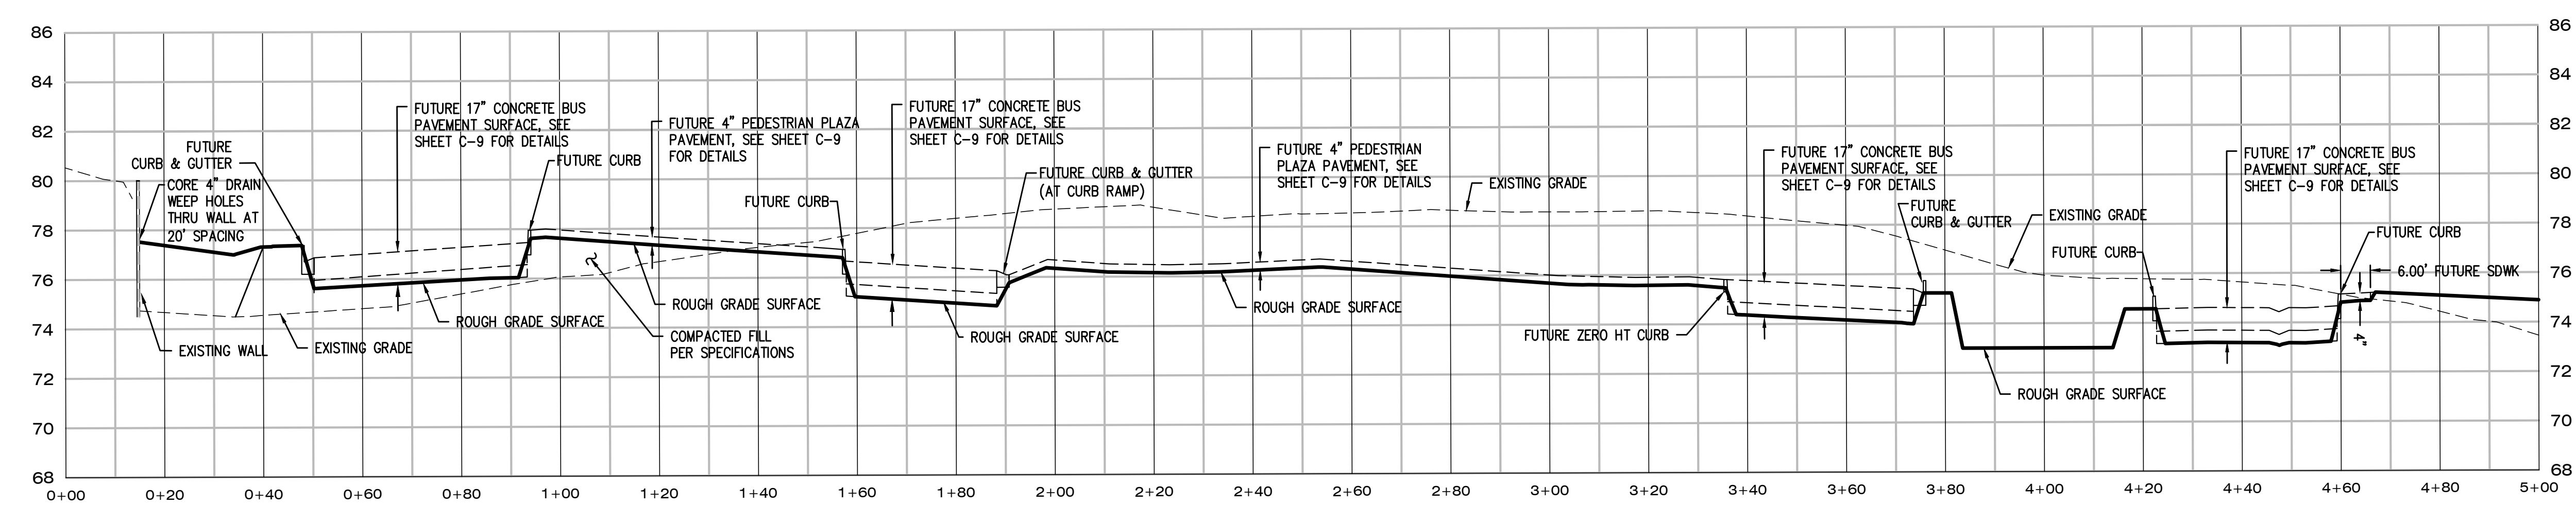

**SITE SECTION C**  
SCALE: 1"=20' H, 1"=4' V

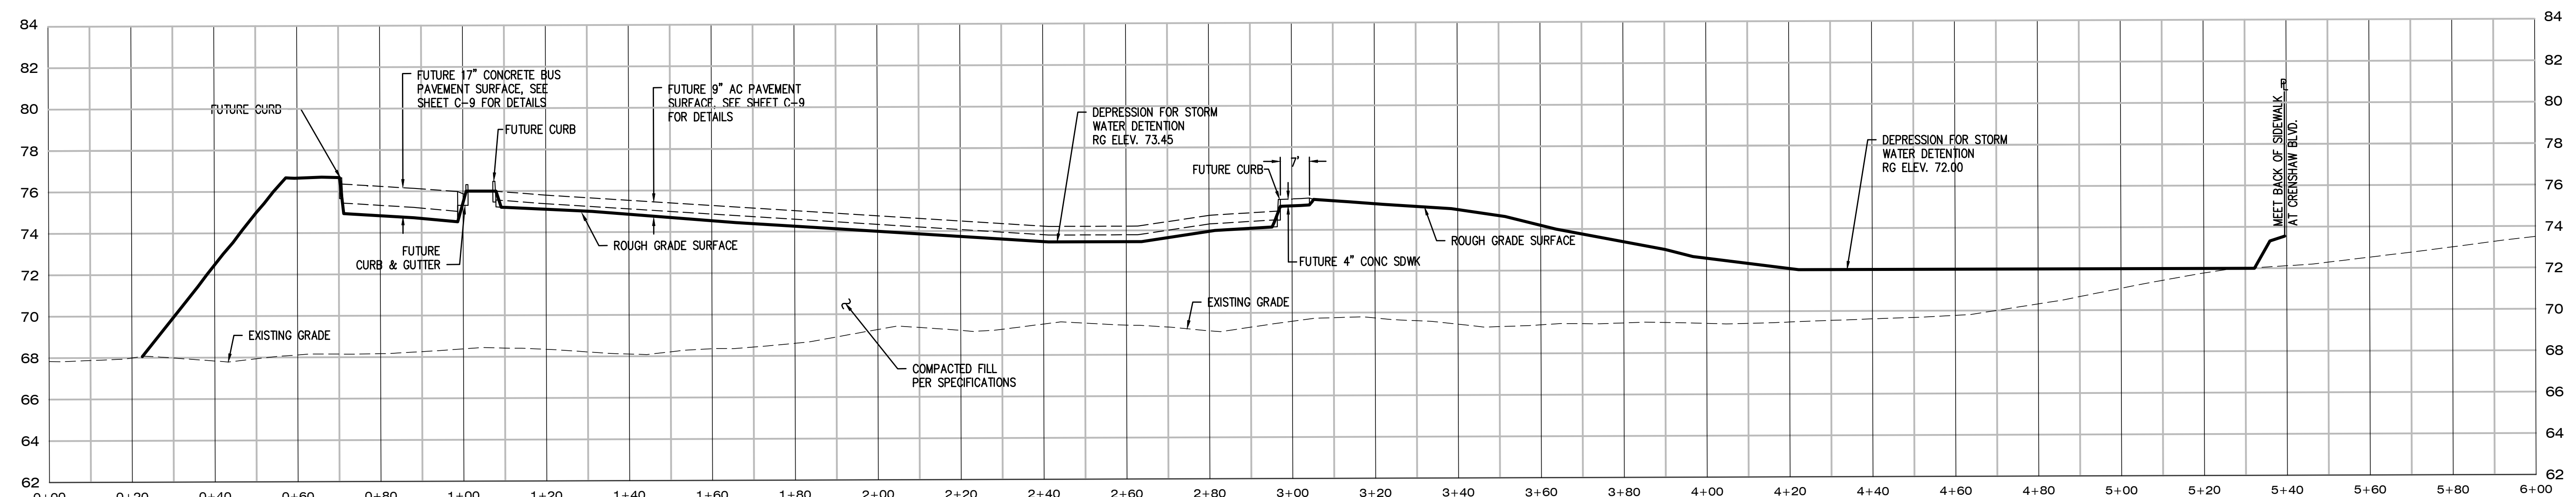

**SITE SECTION F**  
SCALE: 1"=20' H, 1"=4' V

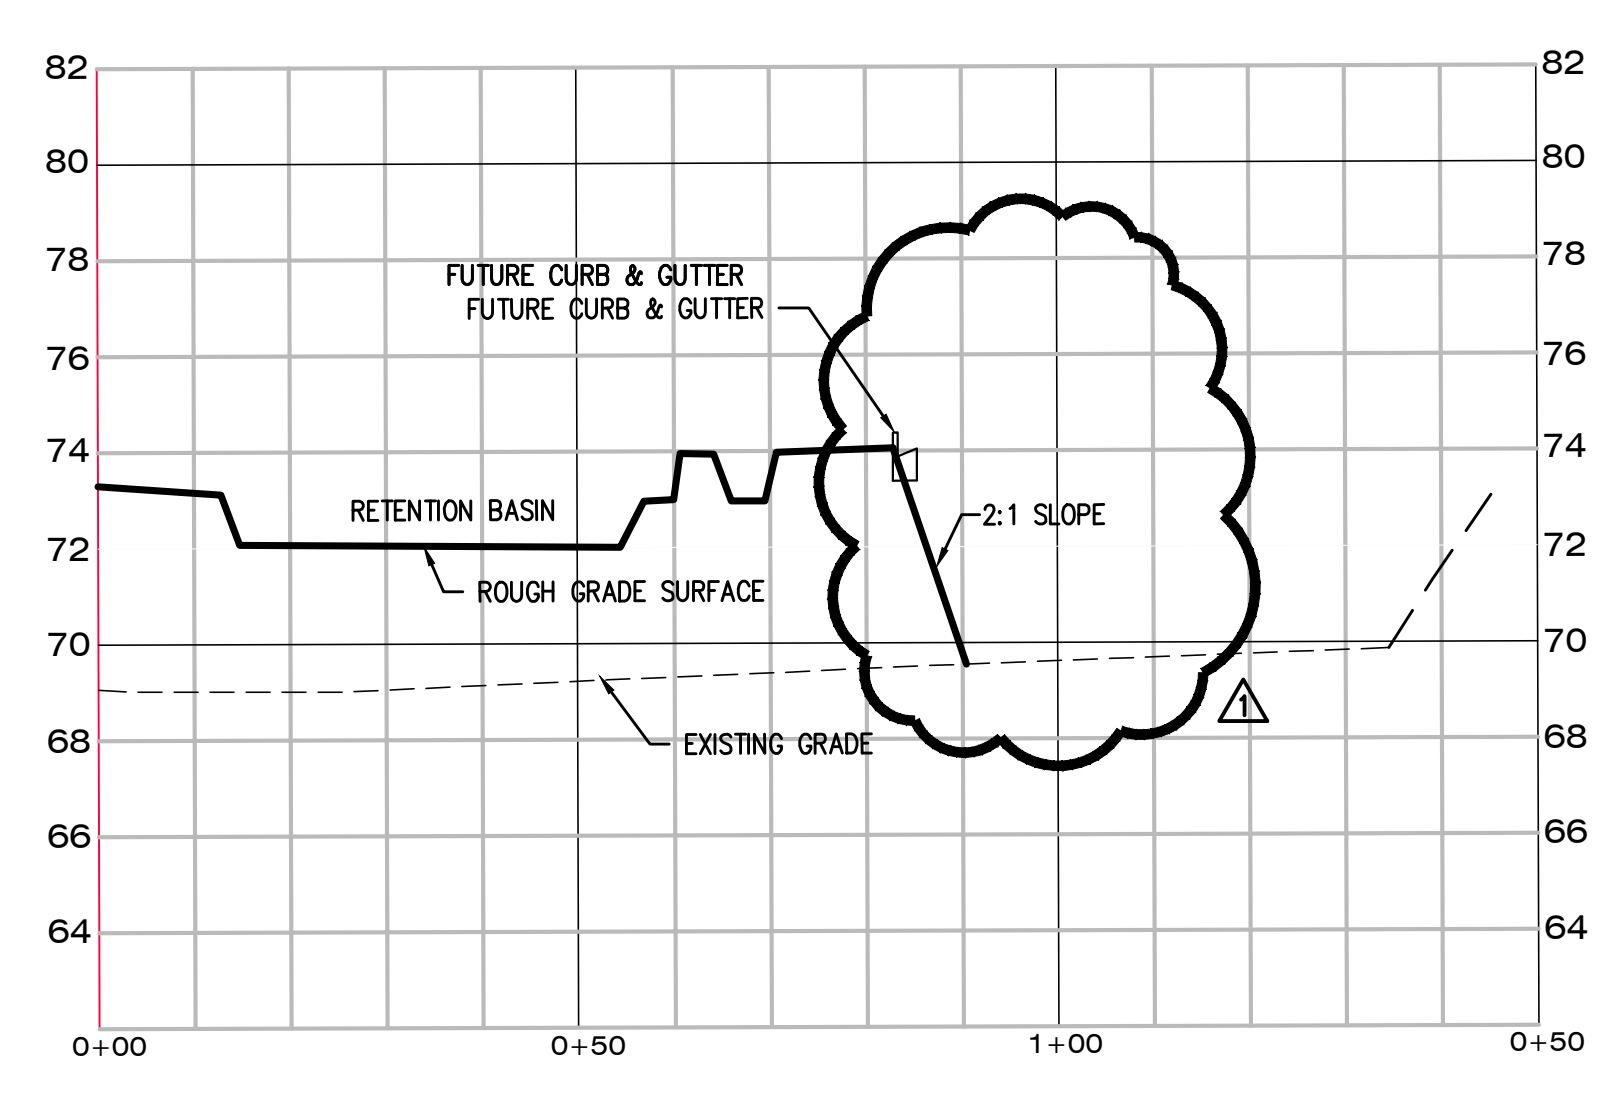


**SITE SECTION G**  
SCALE: 1"=20' H, 1"=4' V

No.	Distribution/Revision	Date
1	REVISE SLOPE AT W. 208TH ST.	10-23-15

**PSOMAS**

3111 Camino Del Rio North, Suite 702  
San Diego, CA 92108  
(619) 961-2800 (619) 961-2392 fax  
www.psomas.com

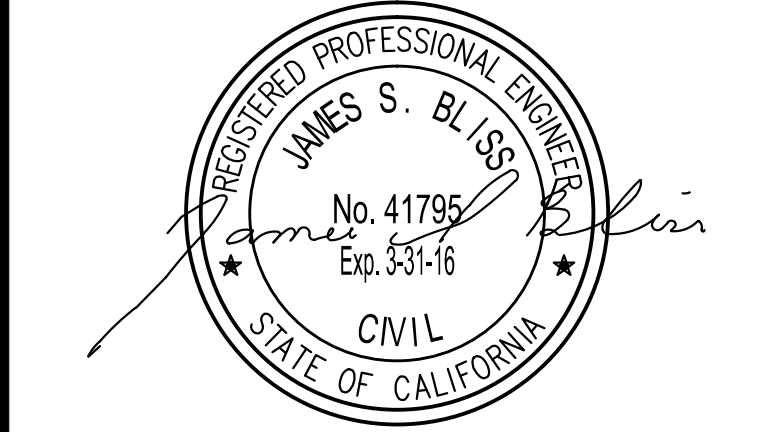

City of Torrance  
Torrance Transit Park & Ride  
Regional Terminal  
465 Crenshaw Blvd.  
Torrance, CA 90503

**Torrance Transit  
Park and Ride  
Regional  
Terminal**

CLIENT PROJECT #B2013-15  
Drawing Title

**SITE SECTIONS**

Scale: NONE  
IF DRAWING IS NOT 30X42 THEN IT IS NOT TO SCALE

Location	LA	Drawing No.	
Project Manager			
Project No.	JSB		
Date Plotted	13025		

**C-6**

Plotted - 10/23/2015 1:58:54 PM :: Saved - 10/23/2015 12:58:18 PM :: S:\FWA01000\_Torrance\_Transit\_Terminal\TRANSIT\PROJECTS\SHEETS\Advanced\DWG\C-6\_XS.dwg, C-6 : : .gwn